AIR FORCE CENTER FOR ENGINEERING AND THE ENVIRONMENT (AFCEE)

FACILITIES DYNAMIC PROTOTYPES DESIGN FOR SECURITY FORCE OPERATIONS BUILDING

100% DESIGN

November 18, 2011

	SHEET LIST
Sheet Number	Sheet Name
A-101	Police Service & Installation Security/ S5
A-102	Guardmount/Armory
A-103	Mobility/Supply
A-104	ECC/ BDOC
A-105	Training/Quality
A-106	Confinement
A-107	Investigation/ S2
A-108	Command/ Orderly
A-109	Back of House Restrooms & General Support
A-110	Break Room & Front of House Restrooms
A-111	Operations & Training/ S3
A-201	Building Rendering 1 - Rendering
A-202	Building Example 1 - Floor Plan
A-203	Building Example 2 - Rendering
A-204	Building Example 2 - Floor Plan
A-205	Building Example 2 - Floor Plan
A-301	Room Finish Schedule
A-302	Room Finish Schedule
A-303	Door Schedule
A-304	Window Schedule

NOT FOR CONSTRUCTION

Drawing Title:

Cover Sheet

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BUILDING

OPER,

N9/S

FLOOR FINISH LEGEND


EVERY WALL IS GENERIC UNLESS SPECIFICALLY NOTED

GENERAL NOTES


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CERAMIC TILE




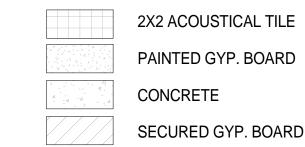

CEILING LEGEND

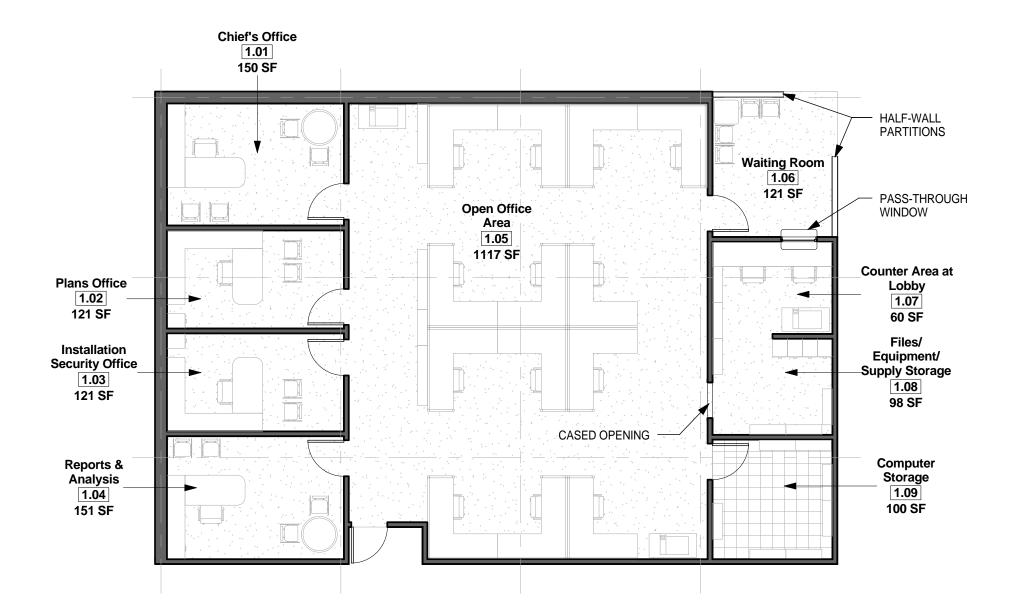

Module 1 - Police Service & Installation Security/ S5 - Floor Plan
1/8" = 1'-0"

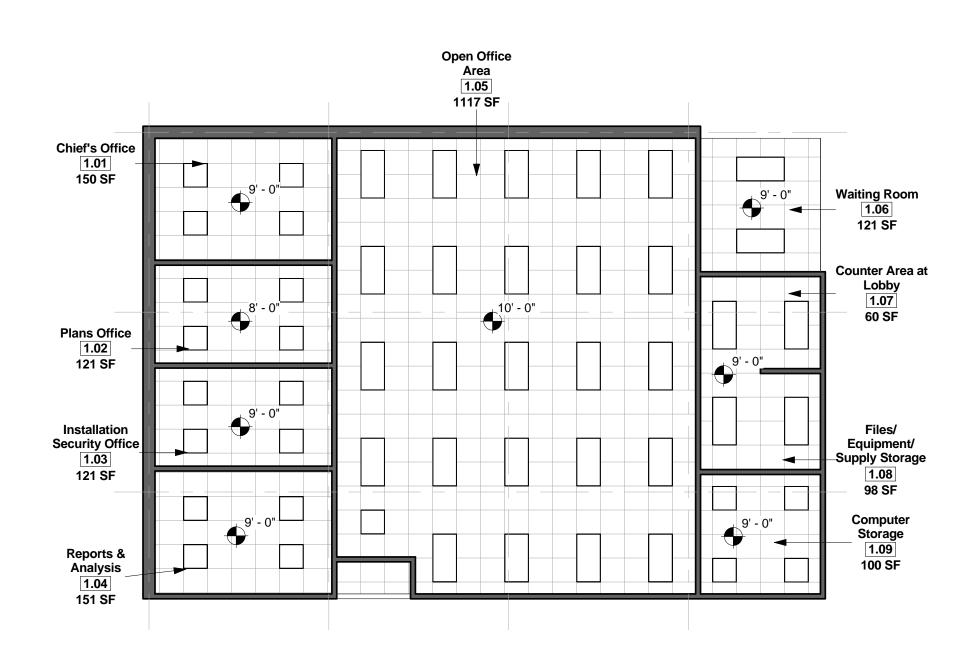


Module 1 - Police Station & Installation

Security/ S5 - Reflected Ceiling Plan

1/8" = 1'-0"



Module 1 - Police Service & Installation Security/ S5 - Axon.

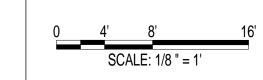

Jacobs Project No.:

AIR

Drawing Title:

Police Service & Installation Security/ S5

18 NOVEMBER 2011

Designed By: JN/MRB/OF | Drawing No.: Drawn By: JN/MRB/OF
Checked By: JS

A-101

Module 2 - Guardmount & Armory

2 Module 2 - Guardmount & Armory - Reflected Ceiling Plan 1/8" = 1'-0"

JACOBS

NOT FOR

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OPER,

Jacobs Project No.:

Drawing Title:

Guardmount/Armory

FDWD0262

18 NOVEMBER 2011 Designed By: JN/MRB/OF | Drawing No.:

Drawn By: JN/MRB/OF
Checked By: JS

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FLOOR FINISH LEGEND **CEILING LEGEND**

CARPET **EPOXY PAINT**

SEALED CONCRETE

CERAMIC TILE

VCT TILE

CONCRETE SECURED GYP. BOARD

2X2 ACOUSTICAL TILE

PAINTED GYP. BOARD

Maintenance Supply 3.01 400 SF OPEN SPACE TO UNLOAD PALLETS - SHELVING (TYP.) EQ

Supply Room
3.04

PASS-THROUGH WINDOW

Hazmat Storage

Module 3 - Mobility and Supply - Floor Plan
1/8" = 1'-0"

Circulation
3.07
185 SF


Logistics Officer 3.03 120 SF

Advisor Resource Office

3.05 120 SF


Open Office

Area 3.02 224 SF

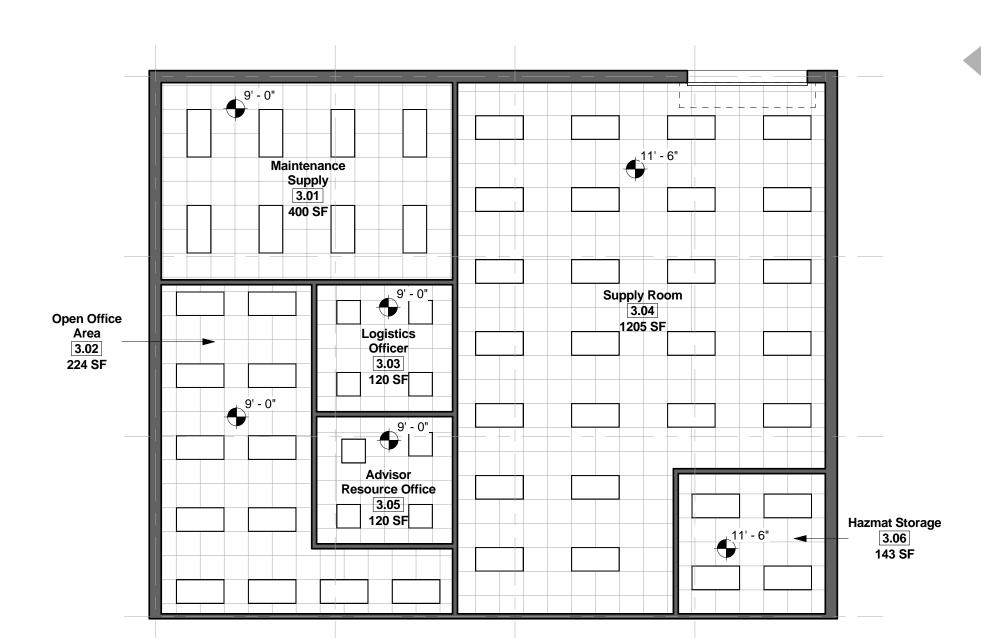

2 Module 3 - Mobility and Supply - Reflected Ceiling Plan 1/8" = 1'-0"



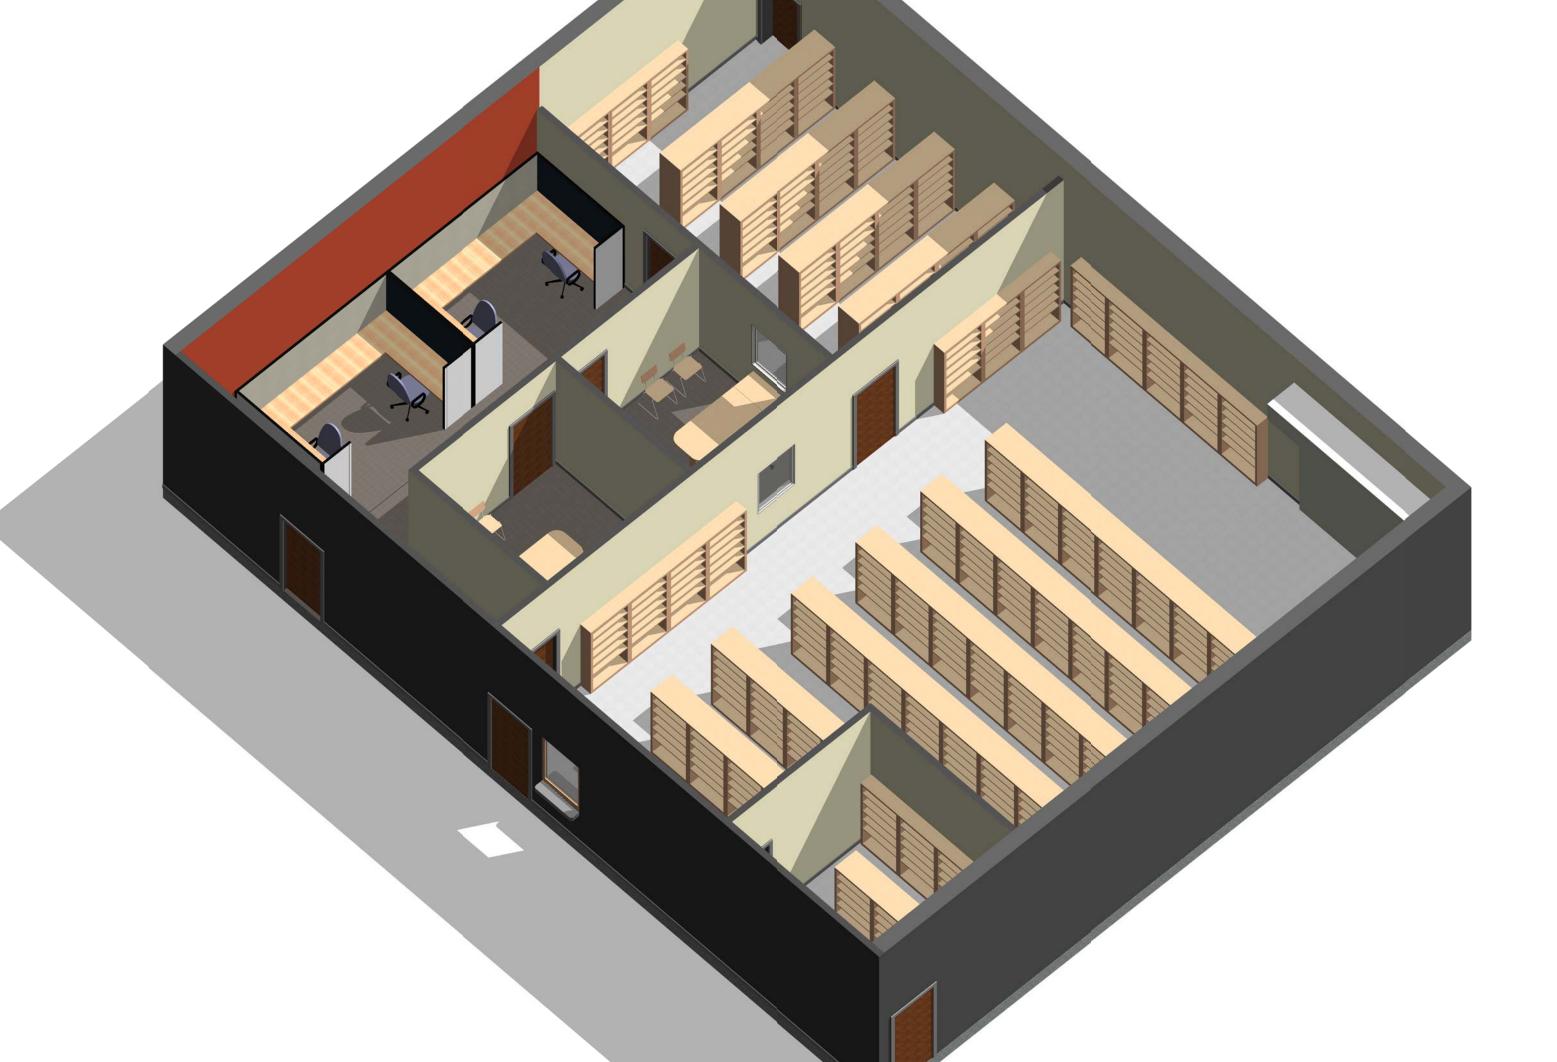

GENERAL NOTES

EVERY WALL IS GENERIC UNLESS SPECIFICALLY NOTED EVERY WALL IS A PLACE HOLDER AS THE MODULES ARE COMBINED TO CREATE A FACILITY,

SPACE OPEN TO ADJACENT SPACES WITHIN THE FACILITY

ALL MODULES HAVE BEEN ORGANIZED BASED ON A 15' GRID.

DISCRETION SHOULD BE USED AS TO WHICH WALLS NEED TO BE MOVED, ADDED OR REMOVED

IF NO WALL IS PRESENT, IT IS THE DESIGN INTENT TO LEAVE THAT

ALL FURNITURE IS A PLACE HOLDER UNLESS SPECIFICALLY NOTED

OP **FACILITIES** SECURITY AIR

SCALE: 1/8 " = 1'

Jacobs Project No.:

Drawing Title:

Mobility/Supply

18 NOVEMBER 2011

Designed By: JN/MRB/OF | Drawing No.: Drawn By: JN/MRB/OF
Checked By: JS

A-103

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BUILDING

LIONS

OPER,

CEILING LEGEND

SECURED GYP. BOARD

FLOOR FINISH LEGEND 2X2 ACOUSTICAL TILE PAINTED GYP. BOARD **EPOXY PAINT** SEALED CONCRETE CONCRETE


CARPET

VCT TILE

CERAMIC TILE

Waiting Area 4.05 139 SF 126 SF Comunication Room 4.03 Interview Room 4.06 73 SF 144 SF 4.19 4.02 83 SF B 4.07 73 SF Restroom 4.08 50 SF 4.09 510 SF Storage - 4.17 90 SF 4.12 Flight Sergeant 4.10 120 SF 133 SF 4.14 92 SF Flight Chief 4.11 -178 SF Patrol Room 4.13 164 SF - FIXED SEATING (TYP.)

1 Module 4 - ECC/ BDOC - Floor Plan 1/8" = 1'-0"

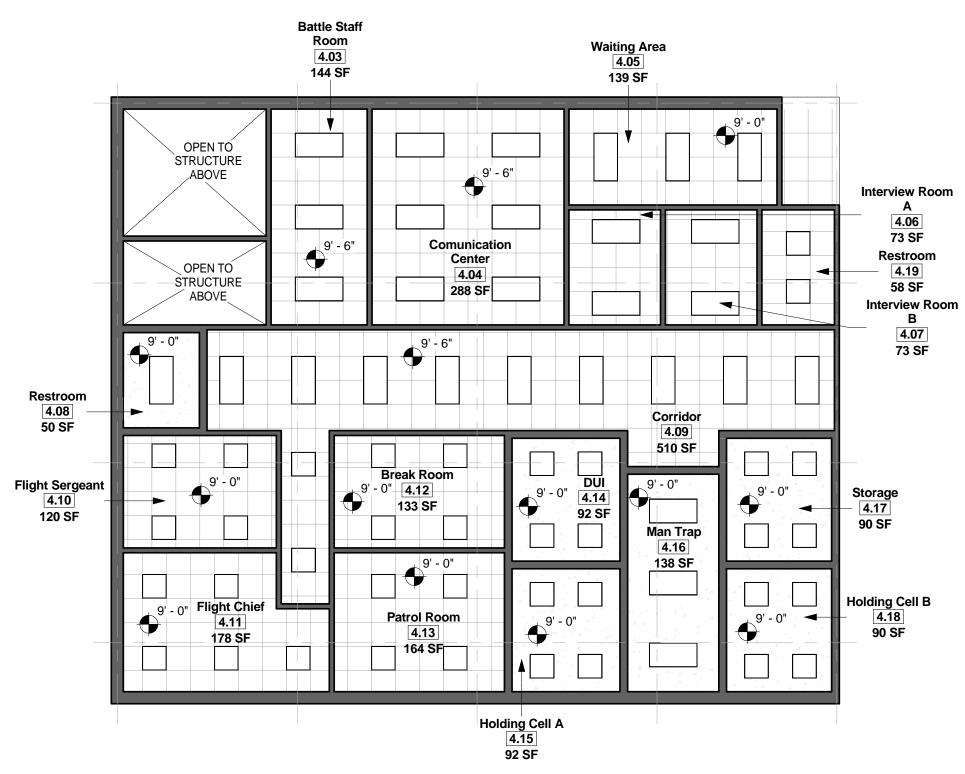

2 Module 4 - ECC/ BDOC - Reflected Ceiling Plan 1/8" = 1'-0"

Module 4 - ECC/ BDOC - Axon.

GENERAL NOTES

MOVED, ADDED OR REMOVED

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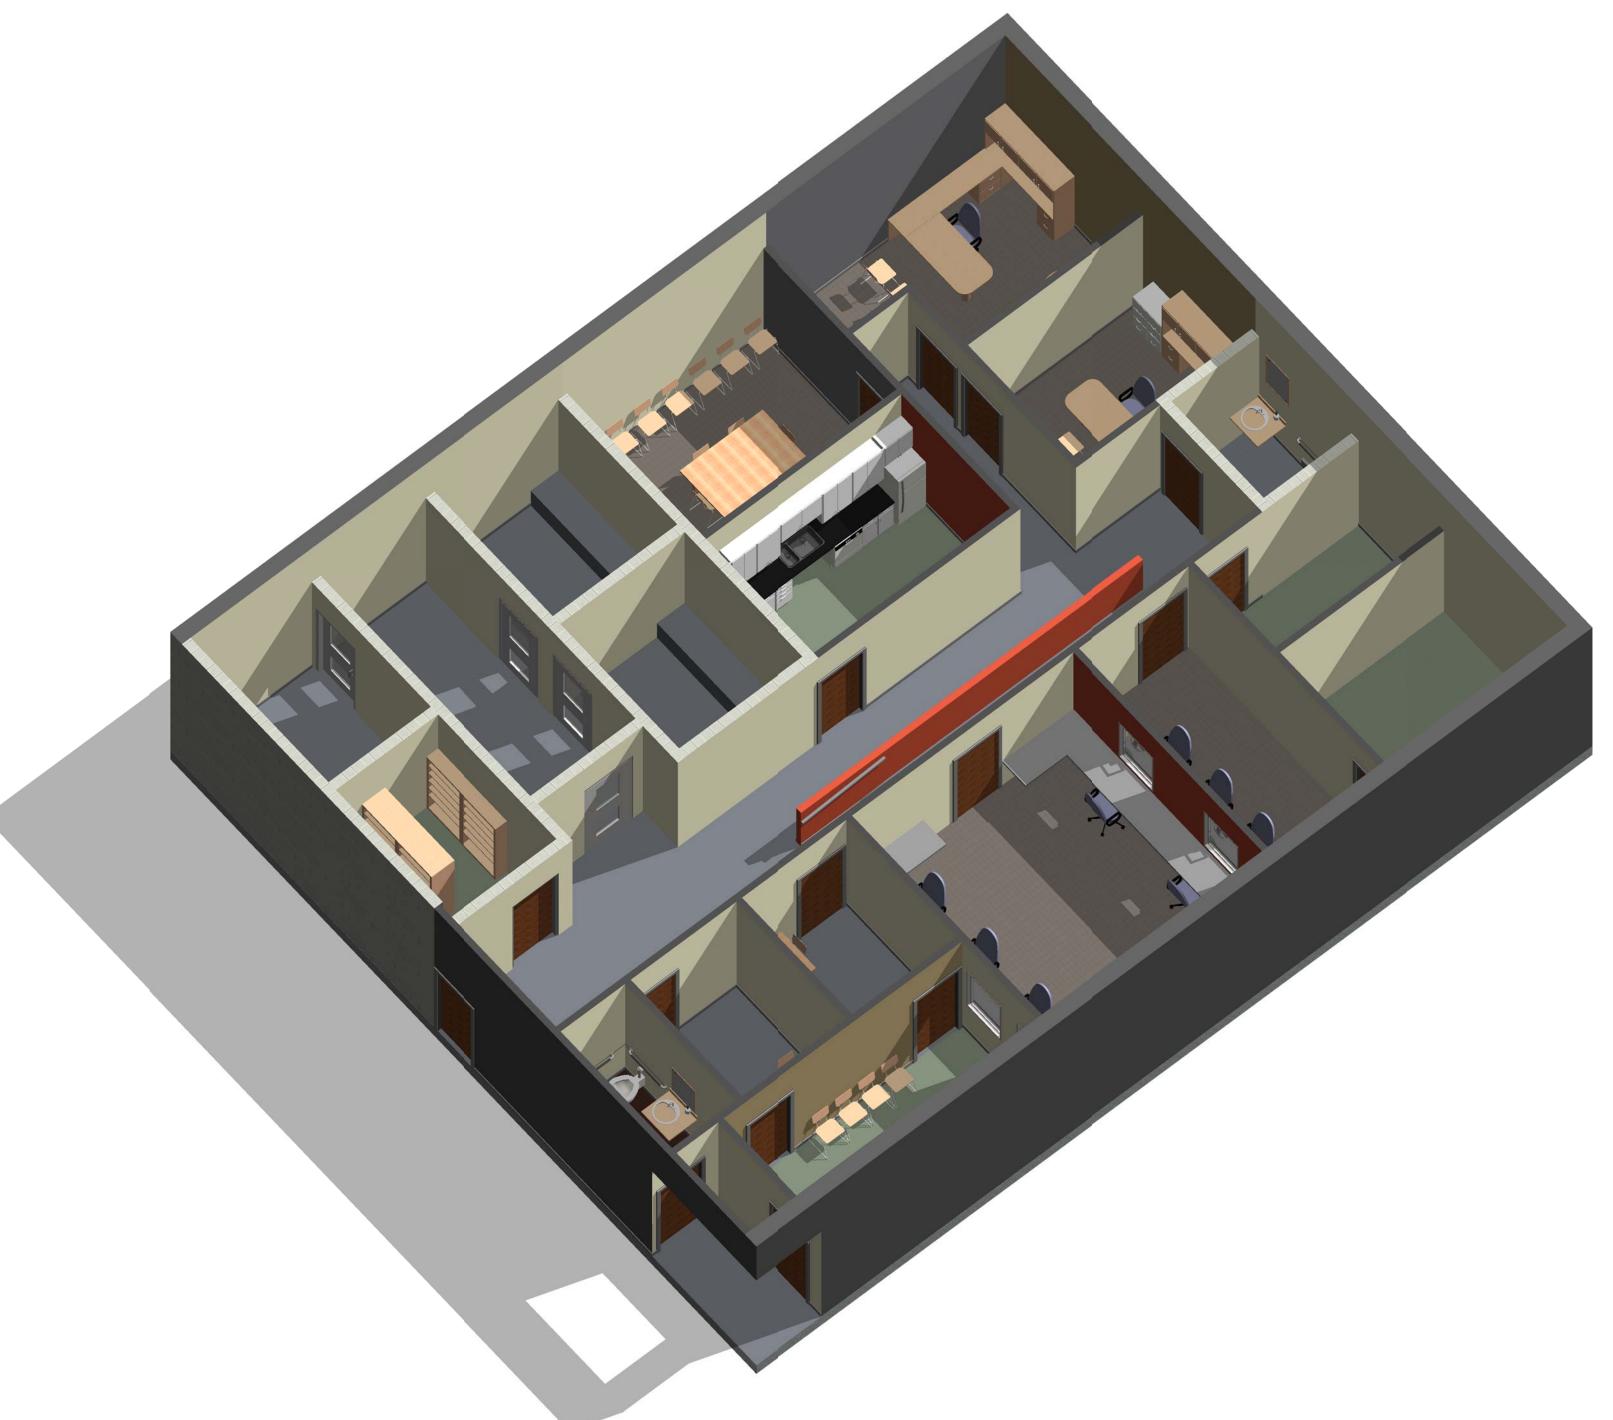
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N9/S

SCALE: 1/8 " = 1'

Jacobs Project No.:

Drawing Title:

ECC/ BDOC

FDWD0262

18 NOVEMBER 2011 Designed By: JN/MRB/OF | Drawing No.:

A-104 Checked By: JS

Designed By: JN/MRB/OF | Drawing No.:

A-105

Drawn By: JN/MRB/OF Checked By: JS

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DING SIG R F(ON)

SCALE: 1/8 " = 1'

Jacobs Project No.:


Drawing Title:

Confinement

FDWD0262

Date: 18 NOVEMBER 2011 Designed By: JN/MRB/OF | Drawing No.: Drawn By: JN/MRB/OF Checked By: JS



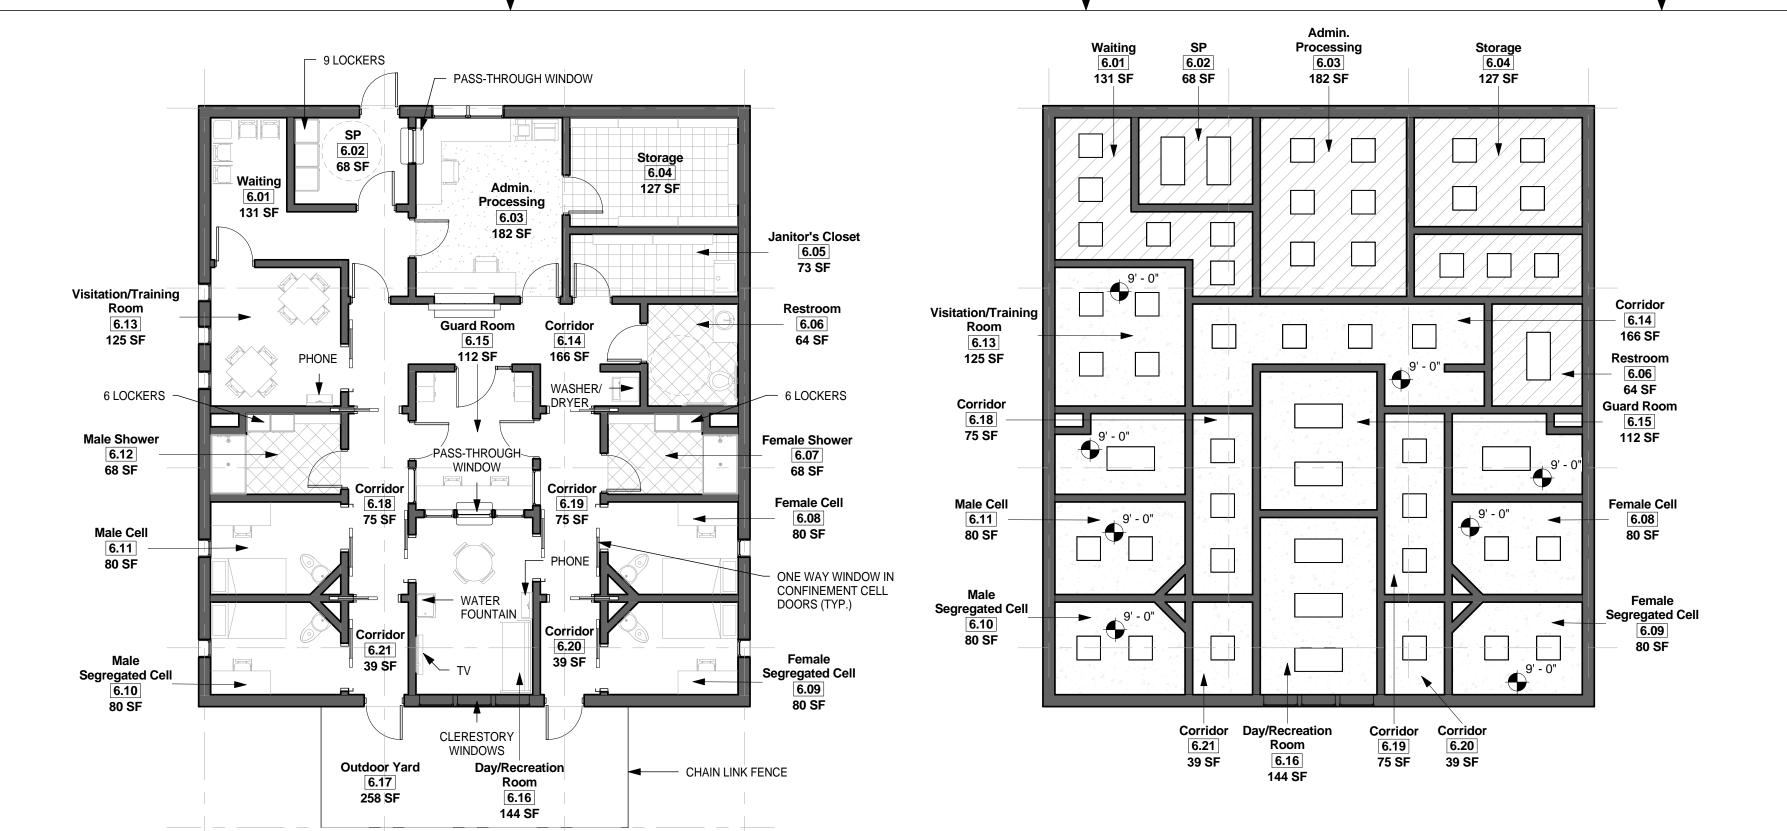

2 Module 6 - Confinement - Reflected Ceiling Plan 1 Module 6 - Confinement - Floor Plan 1/8" = 1'-0" 1/8" = 1'-0"



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FLOOR FINISH LEGEND

CERAMIC TILE

CEILING LEGEND

2X2 ACOUSTICAL TILE CARPET **EPOXY PAINT** PAINTED GYP. BOARD SEALED CONCRETE CONCRETE VCT TILE SECURED GYP. BOARD

CONFINEMENT MODULE NOTES

- USE CORRECTIONAL LIGHTING (TAMPER PROOF LENSES/BALLASTS).
- PROVIDE AN EXTERIOR LOCKED "KNOX BOX" IF BUILT AS A STAND ALONE FACILITY.
- FIRE ESCAPE ELECTRONIC RELEASE DOORS TO OUTDOOR RECRETIONAL YARD WILL BE CONNECTED TO ECC/ BDOC'S BACKUP GENERATOR.
- USE SECURITY HARDWARE (SCREWS/BOLTS) THROUGHOUT.

- PROVIDE ACCESS CONTROL PANEL TO CONTROL SALLY PORT AND OUTDOOR RECREATIONAL YARD EXIT DOORS. PROVIDE REDUNDANT DISPLAY APPLICABILITY (RDA) TO CONTROL SALLY PORT DOORS FROM ADMIN. & GUARD
- PROVIDE LOCKABLE, WALL-MOUNTED KEY BOX & SMALL LOCKABLE SECURITY DRAWER/SAFE.
- USE ONE WAY GLASS ON WINDOWS TO PREVENT CONFINEES'/VISITORS' VIEW TO STAFF.
- OPTIONAL. USE ACOUSTICAL TILES IN CEILING.

- PROVIDE LOCKABLE, WALL-MOUNTED KEY BOX & LOCKABLE MEDICINE STORAGE BOX.
- PROVIDE AN ON/OFF SWITCH FOR THE PHONE IN THE VISITATION/ TRAINING ROOM.
- USE ONE WAY GLASS TO PREVENT CONFINEES' VIEW TO STAFF.
- OPTIONAL. USE ACOUSTICAL TILES IN CEILING.

DAY/ RECREATION ROOM

IN COLD-WEATHER CLIMATES, PROVIDE EXTRA SPACE FOR EXERCISE EQUIPMENT.

DOORS SHOULD NOT SWING IN.

CONFINEMENT CELLS PROVIDE AN ON/OFF SWITCH OUTSIDE OF THE CELL TO CONTROL THE ELECTRICAL OUTLET WITHIN THE CELL.

PROVIDE A METAL DEMOUNTABLE BED (WALL AND/OR FLOOR MOUNTED), DESK, SHELF, AND BREAKAWAY

- CLOTHES HOOK IN EACH CELL
- USE SECURITY ONE-PIECE SAFETY MIRRORS.
- USE ALL IN ONE TOILET, BUBBLER, AND SINK.
- USE EMERGENCY LIGHTING (BACKUP POWERED) AND TAMPER-PROOF (DETENTION) LIGHTING.
- CELL DOORS SHOULD NOT HAVE ONE WAY GLASS AND CAN EITHER SLIDE OR OPEN OUT.
- DO NOT USE BASEBOARDS.

BETWEEN THE MALE AND FEMALE CELLS, USE SLIDING, POCKET, OR BIFOLD DOORS. THE PRIMARY FUNCTION OF THIS DOOR IS FOR SOUND ABATEMENT.

SHOWERS1. USE BREAKAWAY CLOTHES HOOKS.

1. ENSURE SALLY PORT IS LONG AND WIDE ENOUGH FOR AN EMS STRETCHER/GURNEY TO PASS THROUGH.

INSTITUTION SHOWER DOORS ARE CENTERED HALF-DOORS (TOP AND BOTTOM OPEN). USE SOLID MINIMUM INSTITUTION RATED DOORS TRHOUGHOUT. CELL AND CORRIDOR DOORS SHOULD BE

MAXIMUM SECURITY RATED.

THE ENTIRE CONFINEMENT AREA FOOTPRINT NEEDS TO BE SOLID SECURITY RATED TO LEVEL 1 CONFINEMENT WALLS. THE WALLS SHOULD BE 8-INCH THICK CONCRETE MASONRY UNITS WITH CELLS FILLED FULL HEIGHT WITH GROUT CONFORMING TO ASTM C476; VERTICAL REINFORCEMENT NOT REQUIRED FOR SECURITY; EXTEND WALL TO UNDERSIDE OF STRUCTURE. CRITERIA DOES NOT PRECLUDE THE USE OF OTHER MATERIALS MORE READILY AVAILABLE IN THE LOCAL MARKET PROVIDED THEY MEET OR EXCEED THE BASIC REQUIREMENTS.

CEILING CONSTRUCTIONDV

THE CELL CEILING SYSTEM SHALL BE CAST-IN-PLACE CONCRETE WITH A MINIMUM THICKNESS OF 5 INCHES OF REINFORCED CONRETE WITH 6X6 - W1.4 X W1.4 WELDED WIRE FABRIC. SLAB AREA EXPOSED TO THE CELL SHALL HAVE A STEEL TROWEL FINISH. THE ENTIRE CONFINEMENT AREA CAN BE MADE THIS WAY OR THE CIRCUMFERENCE OF THE AREA WOULD NEED TO HAVE 14 GAUGE STEEL PLATE FROM FLOOR TO DECK (TO PREVENT CONFINEES ACCESS TO THE ENTIRE SECURITY FORCES COMPLEX CEILING AND ESCAPE VIA A DIFFERENT ROOM IN THE BUILDING).

CEILING LEGEND

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BUILDING

ATIONS

OPER,

SECURITY

SIGN

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- CARPET **EPOXY PAINT** SEALED CONCRETE


CERAMIC TILE

FLOOR FINISH LEGEND


- VCT TILE
- CONCRETE SECURED GYP. BOARD

2X2 ACOUSTICAL TILE

PAINTED GYP. BOARD

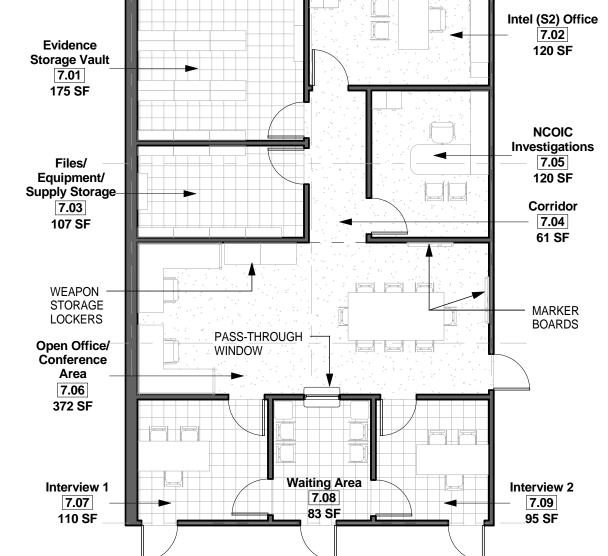

Module 7 - Investigation/ S2 - Floor Plan

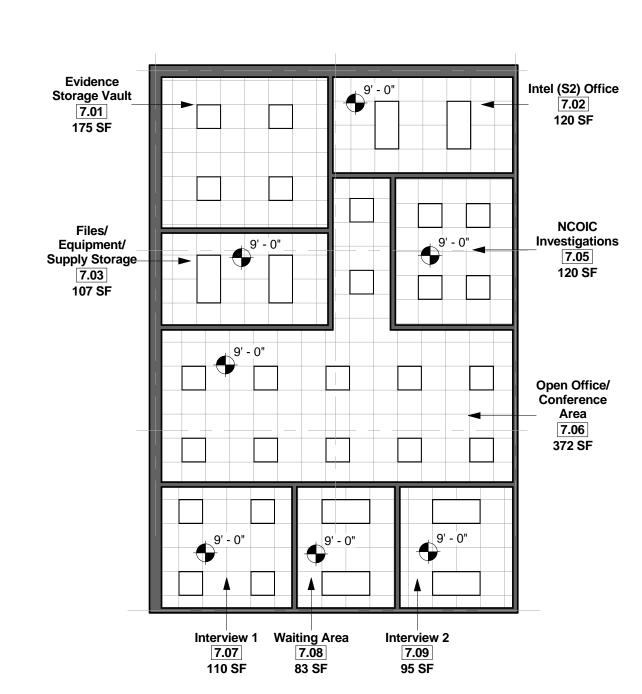

Module 7 - Investigation/ S2 - Reflected Ceiling Plan 1/8" = 1'-0"



1 Module 7 - Investigation/ S2 - Axon.

SCALE: 1/8 " = 1'

FACILITIES

AIR

Jacobs Project No.:

Drawing Title:

Investigation/ S2

18 NOVEMBER 2011

Designed By: JN/MRB/OF | Drawing No.: Drawn By: JN/MRB/OF
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A-107

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FLOOR FINISH LEGEND

EPOXY PAINT

SEALED CONCRETE

CARPET

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CERAMIC TILE

VCT TILE



CONCRETE SECURED GYP. BOARD


2X2 ACOUSTICAL TILE

PAINTED GYP. BOARD

CEILING LEGEND

N9/S


OPER,

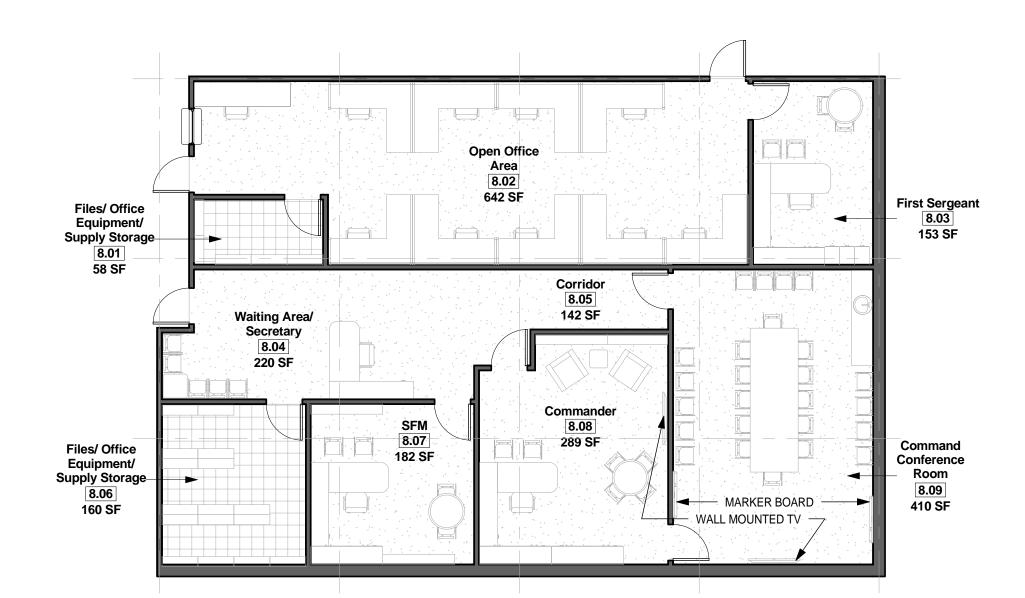

Module - 8 Command and Orderly
1/8" = 1'-0"



2 Module 8- Command and Orderly - Reflected Ceiling Plan 1/8" = 1'-0"

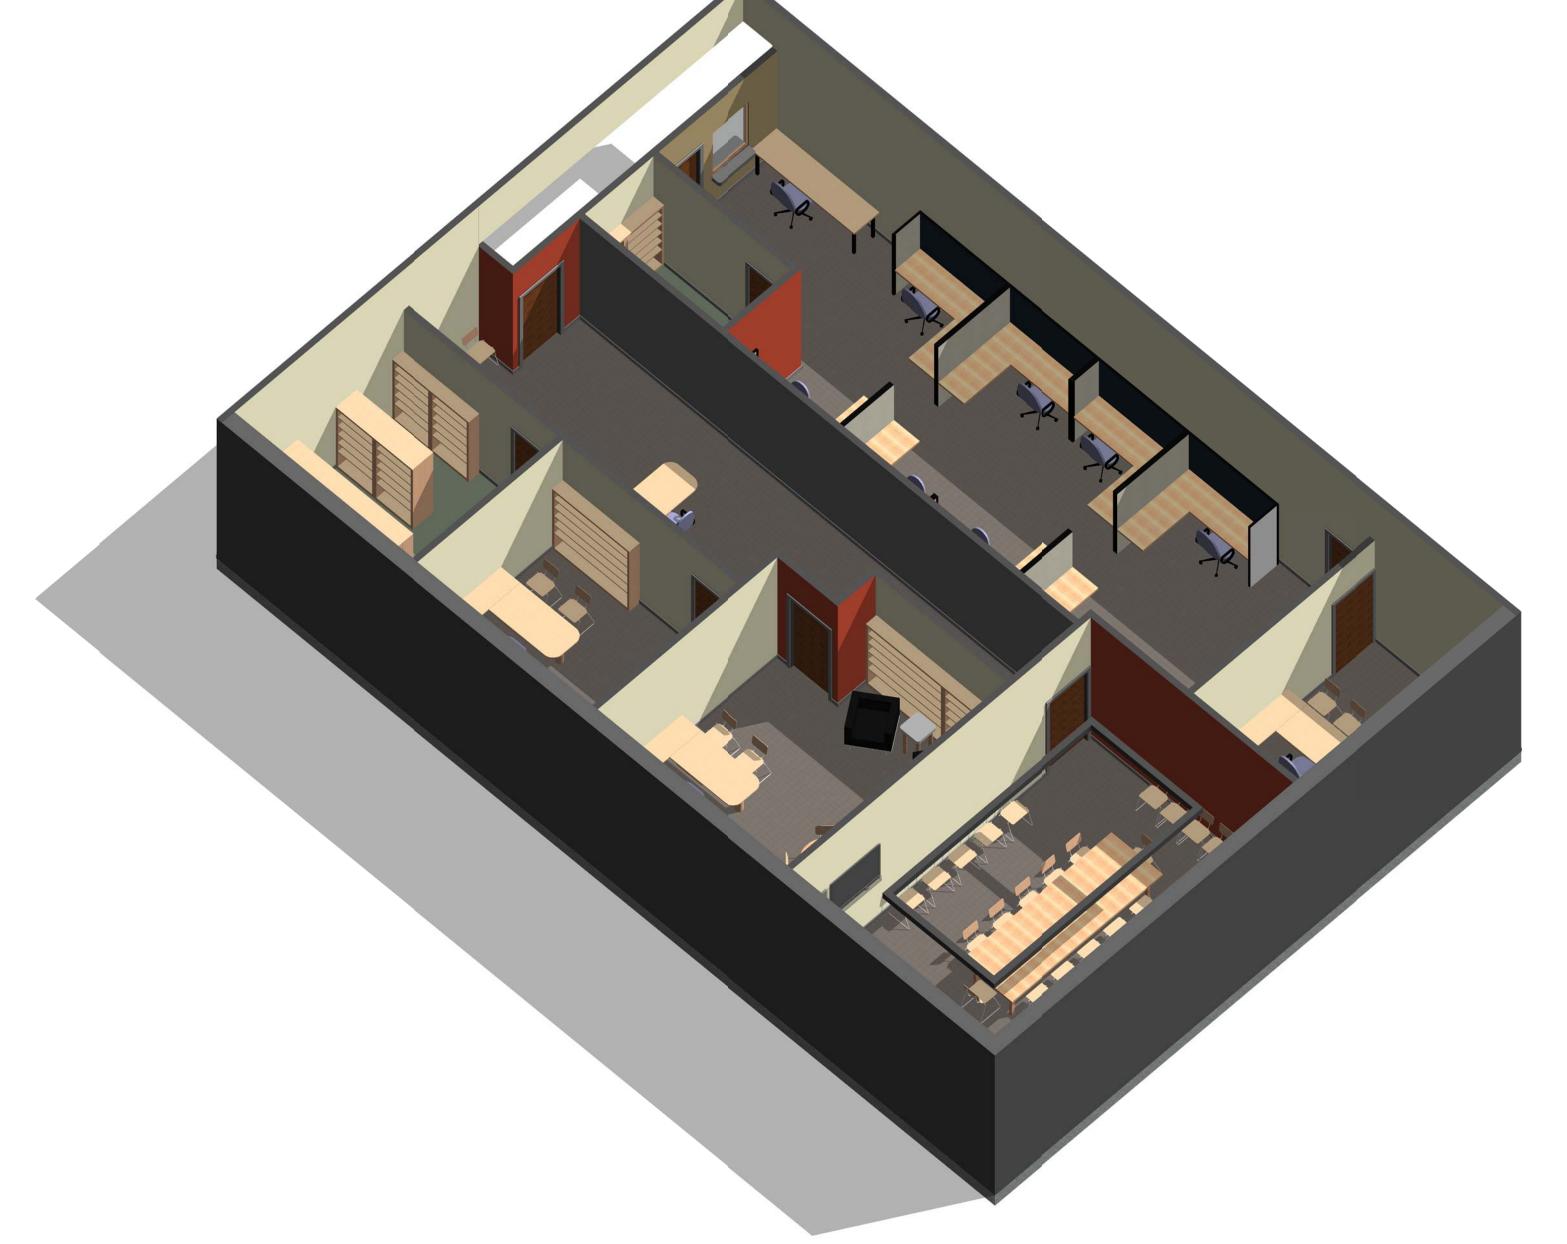

Module 8 - Command and Orderly

SCALE: 1/8 " = 1'

Jacobs Project No.:

AIR

Drawing Title:

Command/ Orderly

18 NOVEMBER 2011

Designed By: JN/MRB/OF | Drawing No.: Drawn By: JN/MRB/OF
Checked By: JS

A-108

GENERAL NOTES

MOVED, ADDED OR REMOVED

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2X2 ACOUSTICAL TILE PAINTED GYP. BOARD CONCRETE SECURED GYP. BOARD

FLOOR FINISH LEGEND

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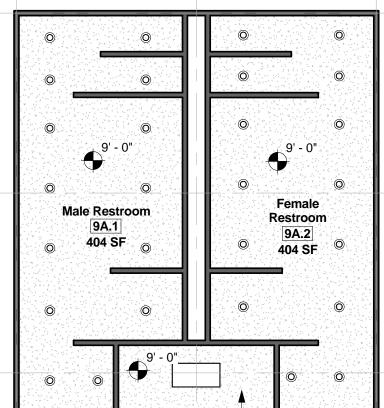
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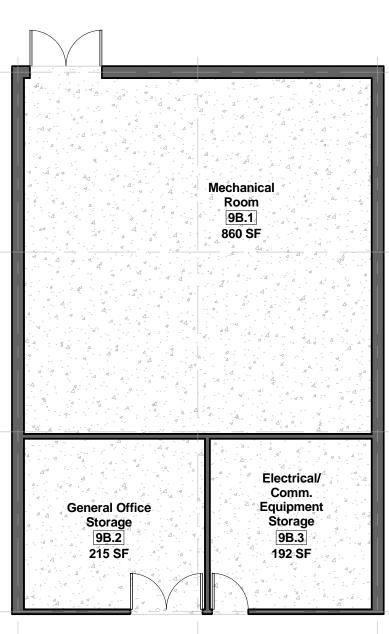
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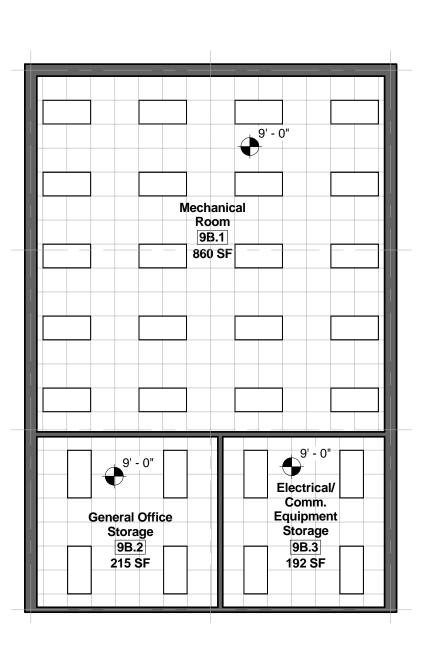
CARPET **EPOXY PAINT** SEALED CONCRETE VCT TILE CERAMIC TILE

CEILING LEGEND





2 Module 9B - General Support - Floor Plan 1/8" = 1'-0"



Module 9B - General Support - Reflected Ceiling Plan
1/8" = 1'-0"

О

SCALE: 1/8 " = 1'

Jacobs Project No.:

Drawing Title:

AIR FORCE CENTER FO THE ENVIRONM FACILITIES DYNAMIC PRO

FACILITIES


Back of House Restrooms & General

Support

Date: 18 NOVEMBER 2011

Designed By: JN/MRB/OF | Drawing No.:

FDWD0262

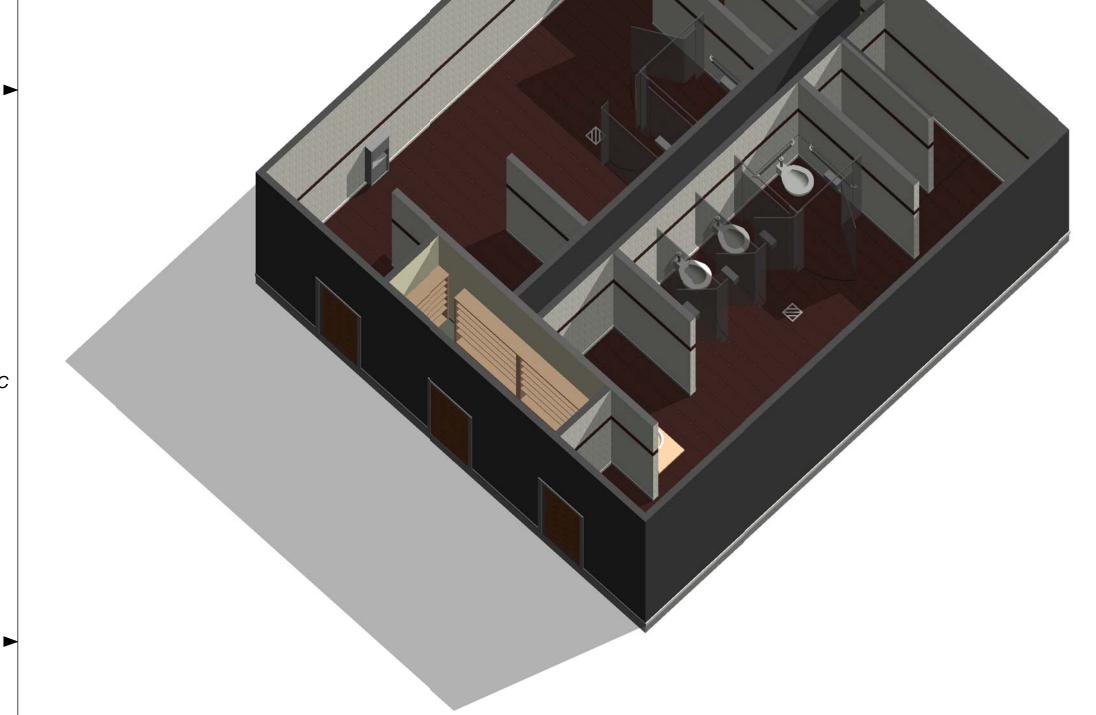

1 Module 9A - Back of House Restrooms - Axon.

Restroom 9A.2 404 SF

Janitor 9A.3 69 SF 3 Module 9A - Back of House Restrooms - Floor Plan 1/8" = 1'-0" Janitor 9A.3 69 SF

Module 9A - Back of House Restrooms - Reflected Ceiling Plan

1/8" = 1'-0"

6 Module 9B - General Support - Axon.

CEILING LEGEND NOT FOR

CONSTRUCTION

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FLOOR FINISH LEGEND


EVERY WALL IS GENERIC UNLESS SPECIFICALLY NOTED


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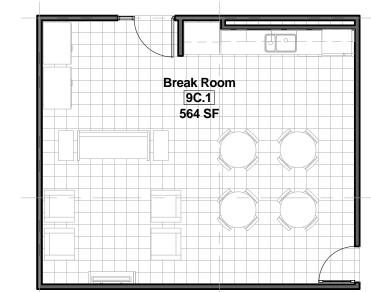
EPOXY PAINT VCT TILE

CARPET SEALED CONCRETE




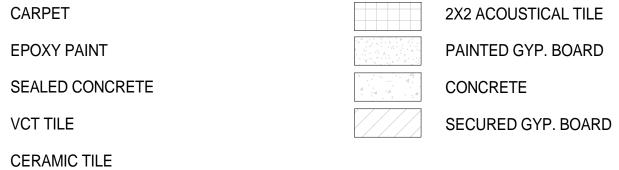


Module 9C - Break Room - Axon.

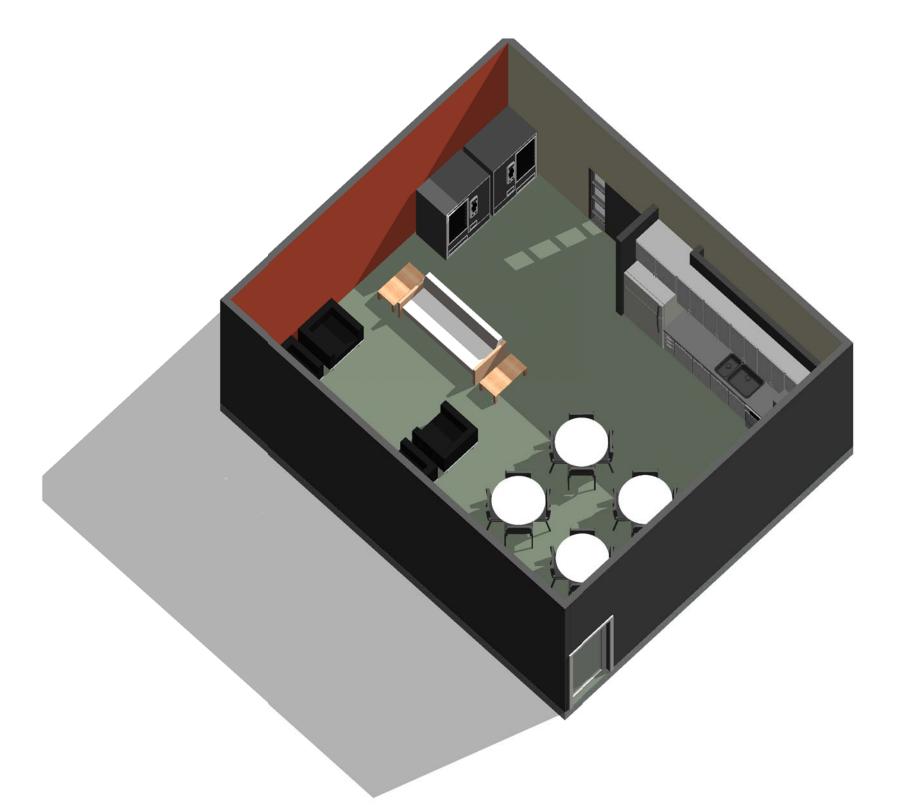


2 Module 9C - Break Room - Floor Plan 1/8" = 1'-0"

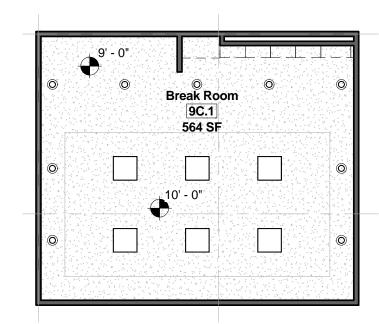


Module 9C - Break Room - Reflected Ceiling Plan
1/8" = 1'-0"

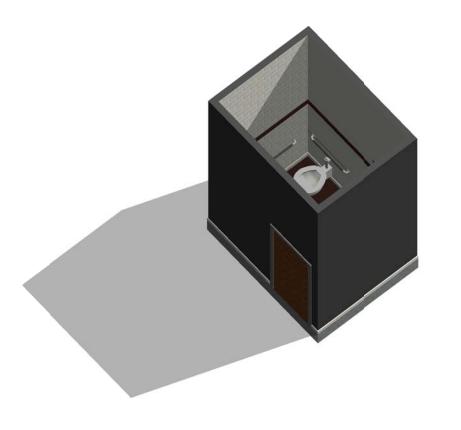


6 Module 9D - Front of House Restrooms - Axon.

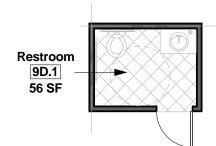

1 Module 9D - Front of House Restrooms - Floor Plan 1/8" = 1'-0"

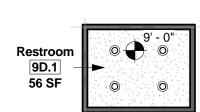

Module 9D - Front of House Restrooms -Reflected Ceiling Plan
1/8" = 1'-0"

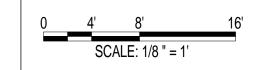

Jacobs Project No.:

Drawing Title:

Break Room & Front of House Restrooms

О

18 NOVEMBER 2011

Designed By: JN/MRB/OF | Drawing No.: Checked By: JS

NOT FOR CONSTRUCTION

911 Central Parkway N., Suite 425 San Antonio, TX 78323

BUILDING

ATIONS

OPER,

N9/S

AND

FLOOR FINISH LEGEND **CEILING LEGEND**

CARPET **EPOXY PAINT**

SEALED CONCRETE


VCT TILE **CERAMIC TILE**

CONCRETE SECURED GYP. BOARD


2X2 ACOUSTICAL TILE

PAINTED GYP. BOARD

501 North Broadway, St. Louis, Missouri 63102-2121

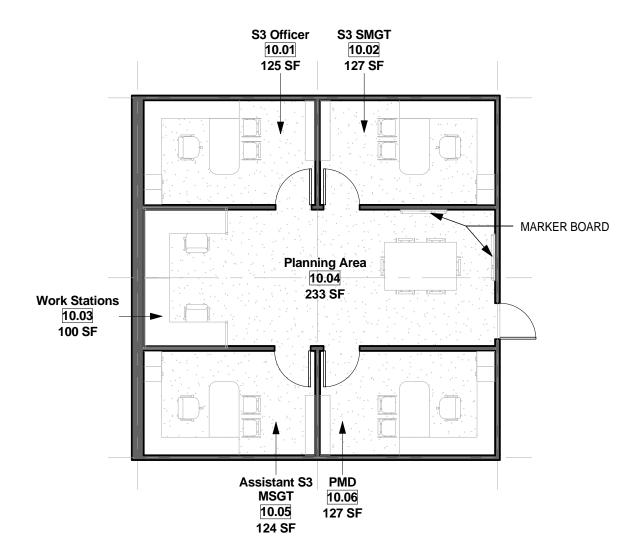

1 Module 10 - Operations & Training/ S3 1/8" = 1'-0"

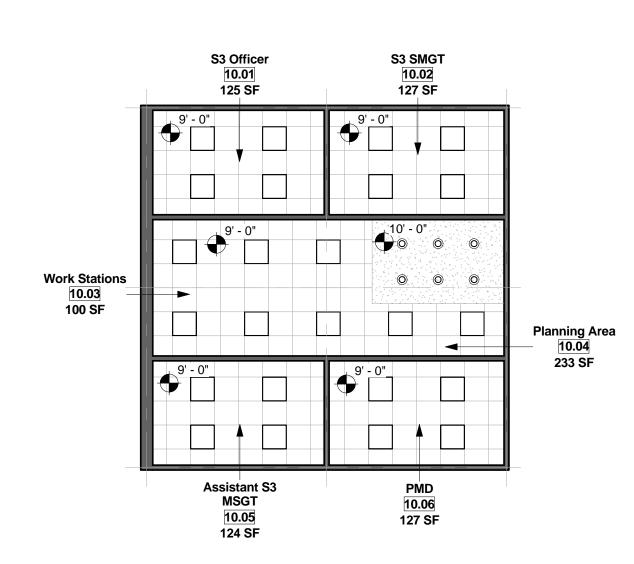

2 Module 10 - Operations & Training - Reflected Ceiling Plan 1/8" = 1'-0"



GENERAL NOTES

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MOVED, ADDED OR REMOVED

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Module 10 - Operations & Training/ S3 - Axon.

SCALE: 1/8 " = 1'

FACILITIES

AIR

Jacobs Project No.:

Drawing Title:

Operations & Training/ **S**3

18 NOVEMBER 2011

Designed By: JN/MRB/OF | Drawing No.: Drawn By: JN/MRB/OF Checked By: JS

A-111

100% DESIGN

SECURITY FORCE OPERATION

Jacobs Project No.: FDWD0262

Drawing Title:

Building Rendering 1 - Rendering

Date: 18 NOVEMBER 2011

Designed By: JN/MRB/OF Drawing No.:

Drawn By: JN/MRB/OF Checked By: JS

Drawing No.:

A-201

JAC

1. THIS BUILDING LAYOUT IS PROVIDED TO ILLUSTRATE ONE POSSIBLE WAY OF ARRANGING THE INDIVIDUAL MODULES. IT IS NOT INTENDED TO CONSTITUTE A FINAL DESIGN.

ARRANGING THE INDIVIDUAL MODULE
NOT INTENDED TO CONSTITUTE A FIN
DESIGN.



CONSTRUCTION

501 North Broadway, St. Louis, Missouri 63102-2121

A-202 Checked By: JS

BUILDING NOTES

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Jacobs Project No.:

FDWD0262

Drawing Title:

Building Example 2 - Rendering

18 NOVEMBER 2011

Designed By: JN/MRB/OF Drawing No.:

Drawn By: JN/MRB/OF
Checked By: JS

A-203

NOT FOR CONSTRUCTION

911 Central Parkway N., Suite 425 San Antonio, TX 78323 501 North Broadway, St. Louis, Missouri 63102-2121

OPER,

Building Example 2 -Floor Plan

Designed By: JN/MRB/OF | Drawing No.:

2 Building Example 2 - Enlarged Floor Plan C 1/8" = 1'-0"

JACOBS

NOT FOR CONSTRUCTION

911 Central Parkway N., Suite 425 San Antonio, TX 78323 501 North Broadway, St. Louis, Missouri 63102-2121

SCALE: 1/8 " = 1'

Jacobs Project No.:

Building Example 2 -Floor Plan

FDWD0262

18 NOVEMBER 2011

Designed By: JN/MRB/OF Drawing No.:

Drawn By: JN/MRB/OF
Checked By: JS

A-205

1. MATERIALS ARE PROVIDED AS SUGGESTIONS ONLY. FINAL FINISHES SHOULD BE EVALUATED AND CHOSEN FOR EACH NEW PROJECT.

GENERAL NOTES

JACOBS

NOT FOR

:	FDWD0262

Jacobs Project No.: F

Drawing Title:

Room Finish Schedule

Date: 18 NOVEMBER 2011

Designed By: JN/MRB/OF Drawing No.:

Drawn By: JN/MRB/OF
Checked By: JS

A-301

	11	NTERIOR FINISH COLOR AND MATERIA	L SCHEDULE
	ITEM	MATERIAL	NOTES
01	WALLS		
(CWT-1	12" X 6" CERAMIC TILE	
	CWT-2	12" X 6" CERAMIC TILE - ACCENT	
E	EWP-1	PAINT - EPOXY TYPICAL	
E	EWP-2	PAINT - EPOXY ACCENT	
E	EWP-3	PAINT - EPOXY ACCENT	
E	EWP-4	PAINT - EPOXY ACCENT	
	PT-1	PAINT - TYPICAL	
	PT-2	PAINT - ACCENT	
	PT-3	PAINT - ACCENT	
	PT-4	PAINT - ACCENT	
02	FLOORS		
(CFT-1	12" X 12" CERAMIC FLOOR TILE	
(CPT-1	2' X 2' CARPET TILE	
	EFP-1	PAINT - EPOXY	
	SC-1	SEALED CONCRETE	
,	VCT-1	12" X 12" VINYL COMPOSITION TILE	
03	BASE		
	CB-1	6" CERAMIC COVE BASE	
	RB-1	5" RUBBER BASE	
04	CEILING	i	
	ACT-1	2' X 2' ACOUSTICAL CEILING TILE	
	GYP.	PAINTED GYPSUM BOARD CEILING	
	OPEN	EXPOSED TO STRUCTURE	
SE	C. GYP.	PAINTED GYPSUM BOARD SECURITY CEILING	
		OLILINO .	
05	MILLWO	RK	
l	_AM-1	PLASTIC LAMINATE - HORIZONTAL SURFACES	
I	_AM-2	PLASTIC LAMINATE - VERTICAL SURFACES	TEXTURE FINI
	00.4	00110 01105405	1

SS-1 SOLID SURFACE

					ROOM FINIS	SH SCHEDULI HES	<u> </u>				
		WALLS							Bim Manual		
Room Number	Room Name	Floor Finish	Base Finish	Plan North Wall	Plan East Wall	Plan South Wall	Plan West Wall	Ceiling Finish	Comments	Required Area	Actual Are
Module 1	: Police Services & Installation Secur		ı								
1.01	Chief's Office	CPT-1	RB-1	PT-1	PT-1	PT-1	PT-4	ACT-1		150 SF	150 SF
1.02	Plans Office	CPT-1	RB-1	PT-1	PT-1	PT-1	PT-4	ACT-1		120 SF	121 SF
1.03	Installation Security Office	CPT-1	RB-1	PT-1	PT-1	PT-1	PT-4	ACT-1		120 SF	121 SF
1.04	Reports & Analysis	CPT-1	RB-1	PT-1	PT-1	PT-1	PT-4	ACT-1		150 SF	151 SF
1.05	Open Office Area	CPT-1	RB-1	PT-1	PT-3	PT-1	PT-2	ACT-1		1100 SF	1117 SF
1.06	Waiting Room	CPT-1	RB-1	PT-2	PT-2	PT-1	PT-1	ACT-1		120 SF	121 SF
1.07	Counter Area at Lobby	CPT-1	RB-1	PT-1	PT-4	PT-2	PT-1	ACT-1		60 SF	60 SF
1.08	Files/ Equipment/ Supply Storage	CPT-1	RB-1	PT-2	PT-4	PT-1	PT-1	ACT-1		100 SF	98 SF
1.09	Computer Storage	VCT-1	RB-1	PT-1	PT-4	PT-1	PT-1	ACT-1		100 SF	100 SF
2.01	Ammunition Storage	SC-1 SC-1	RB-1	PT-1	PT-1	PT-1	PT-1	GYP.		150 SF	150 SF
Module 2	: Guardmount/Armory										
	_					-					
2.03	NCOIC Armory Office	CPT-1	RB-1	PT-4	PT-1	PT-1	PT-1	GYP.		120 SF	119 SF
2.04	Circulation	EFP-1	-	PT-1	PT-1	- CMT 4 /	PT-1	GYP.		0 SF	36 SF
2.05	Restroom	CFT-1	CB-1	CWT-1 / CWT-2	CWT-1 / CWT-2	CWT-1 / CWT-2	CWT-1 / CWT-2	GYP.		60 SF	54 SF
2.06	Gear Lockers	EFP-1	-	EWP-1	EWP-2	EWP-1	EWP-1	GYP.		920 SF	919 SF
2.07	Weapons Issue Area	EFP-1	-	EWP-1	EWP-3	EWP-1	EWP-3	GYP.		220 SF	211 SF
2.08	Weapons Storage	EFP-1	-	PT-1	PT-2	-	PT-1	GYP.		300 SF	300 SF
2.09	Issue Windows	EFP-1	-	PT-1	-	PT-1	PT-1	GYP.		160 SF	165 SF
2.10	Weapons Cleaning Area	SC-1	RB-1	EWP-1	EWP-1	EWP-1	EWP-1	GYP.		120 SF	113 SF
2.11	Transient Weapons Storage	SC-1	RB-1	PT-1	PT-1	PT-1	PT-1	GYP.		100 SF	100 SF
2.12	Personal Weapons Storage	SC-1	RB-1	PT-1	PT-1	PT-1	PT-1	GYP.		64 SF	64 SF
			•					-		1	
Module 3	: Mobility/Supply										
3.01	Maintenance Supply	SC-1	RB-1	PT-1	PT-1	PT-1	PT-1	ACT-1		400 SF	400 SF
3.02	Open Office Area	CPT-1	RB-1	PT-1	-	PT-1	PT-2	ACT-1		220 SF	224 SF
3.03	Logistics Officer	CPT-1	RB-1	PT-1	PT-4	PT-1	PT-1	ACT-1		120 SF	120 SF
3.04	Supply Room	SC-1	RB-1	PT-1	PT-1	PT-1	PT-1	ACT-1		1200 SF	1205 SF
3.05	Advisor Resource Office	CPT-1	RB-1	PT-3	PT-1	PT-1	PT-1	ACT-1		120 SF	120 SF
3.06	Hazmat Storage	SC-1	RB-1	PT-1	PT-1	PT-1	PT-1	ACT-1		140 SF	143 SF
3.07	Circulation	CPT-1	RB-1	PT-1	PT-1	PT-1	-	ACT-1		0 SF	185 SF

4.01	Alarm Room	VCT-1	RB-1	PT-1	PT-1	PT-1	PT-1	OPEN		120 SF	126 SF
4.02	Server Room	VCT-1	RB-1	PT-1	PT-1	PT-1	PT-1	OPEN		80 SF	83 SF
4.03	Battle Staff Room	CPT-1	RB-1	PT-1	PT-2	PT-1	PT-1	ACT-1		150 SF	144 SF
4.04	Comunication Center	CPT-1	RB-1	PT-1	PT-1	PT-1	PT-2	ACT-1		300 SF	288 S
4.05	Waiting Area	VCT-1	RB-1	PT-3	PT-1	PT-1	PT-4	ACT-1		140 SF	139 SI
4.06	Interview Room A	EFP-1	-	EWP-1	EWP-1	EWP-1	EWP-1	ACT-1		80 SF	73 SF
4.07	Interview Room B	EFP-1	-	EWP-1	EWP-1	EWP-1	EWP-1	ACT-1		80 SF	73 SF
4.08	Restroom	EFP-1	-	EWP-1	EWP-1	EWP-1	EWP-1	ACT-1		80 SF	50 SF
4.09	Corridor	EFP-1	-	EWP-1	EWP-1	EWP-1	EWP-1	ACT-1	RAMP SIDE WALL TO BE PAINTED EWP-4	0 SF	510 SI
4.10	Flight Sergeant	CPT-1	RB-1	PT-1	PT-1	PT-1	PT-4	ACT-1		120 SF	120 SI
4.11	Flight Chief	CPT-1	RB-1	PT-1	PT-1	PT-3	PT-4	ACT-1		200 SF	178 SI
4.12	Break Room	VCT-1	RB-1	PT-1	PT-1	PT-1	PT-2	ACT-1		140 SF	133 S
4.13	Patrol Room	CPT-1	RB-1	PT-1	PT-3	PT-1	PT-3	ACT-1		150 SF	164 SI
4.14	DUI	EFP-1	-	EWP-1	EWP-1	EWP-1	EWP-1	ACT-1		90 SF	92 SF
4.15	Holding Cell A	EFP-1	-	EWP-1	EWP-1	EWP-1	EWP-1	SEC. GYP.		90 SF	92 SF
4.16	Man Trap	EFP-1	-	EWP-1	EWP-1	EWP-1	EWP-1	SEC. GYP.		140 SF	138 SI
4.17	Storage	VCT-1	RB-1	PT-1	PT-1	PT-1	PT-1	SEC. GYP.		90 SF	90 SF
4.18	Holding Cell B	EFP-1	-	EWP-1	EWP-1	EWP-1	EWP-1	SEC. GYP.		90 SF	90 SF
4.19	Restroom	CT-3	CB-1	CWT-1 / CWT-2	CWT-1 / CWT-2	CWT-1 / CWT-2	CWT-1 / CWT-2	ACT-1		60 SF	58 SF

5.01	Training Officer Office	CPT-1	RB-1	PT-1	PT-1	PT-1	PT-4	ACT-1	150 SF	154 SF
5.02	Superintendant	CPT-1	RB-1	PT-1	PT-3	PT-1	PT-1	ACT-1	150 SF	154 S
5.03	Classroom A	CPT-1	RB-1	PT-1	PT-4	-	PT-3	ACT-1	750 SF	752 S
5.04	Quality Control NCOIC Office	CPT-1	RB-1	PT-1	PT-1	PT-1	PT-3	ACT-1	120 SF	120 S
5.05	Private Testing Room A	CPT-1	RB-1	PT-1	PT-4	PT-1	PT-1	ACT-1	80 SF	77 SF
5.06	Private Testing Room B	CPT-1	RB-1	PT-1	PT-3	PT-1	PT-1	ACT-1	80 SF	77 SF
5.07	Shared Office	CPT-1	RB-1	PT-1	PT-1	PT-1	PT-4	ACT-1	130 SF	132 S
5.08	Study Carrells	CPT-1	RB-1	PT-1	PT-4	PT-1	PT-1	ACT-1	120 SF	117 S
5.09	Open Office Area	CPT-1	RB-1	PT-1	-	PT-1	PT-3	ACT-1	400 SF	407 S
5.10	Storage	CPT-1	RB-1	PT-1	PT-1	PT-1	PT-1	ACT-1	50 SF	55 SF
5.11	Circulation	CPT-1	RB-1	PT-1	PT-2	PT-1	PT-1	ACT-1	0 SF	316 S
5.12	Central Conference Area	CPT-1	RB-1	PT-1	PT-3	PT-2	PT-2	GYP.	150 SF	145 S
5.13	Classroom B	CPT-1	RB-1	-	PT-4	PT-1	PT-3	ACT-1	750 SF	752 S
5.14	Files/Office Equipment/ Supply	VCT-1	RB-1	PT-1	PT-1	PT-1	PT-1	ACT-1	160 SF	165 S
5.15	Classroom Storage	VCT-1	WT	PT-1	PT-1	PT-1	PT-1	ACT-1	130 SF	130 S

1. MATERIALS ARE PROVIDED AS SUGGESTIONS ONLY. FINAL FINISHES SHOULD BE EVALUATED AND CHOSEN FOR EACH NEW PROJECT.

GENERAL NOTES

Τ	JACOBS

NOT FOR CONSTRUCTION

911 Central Parkway N., Suite 425 San Antonio, TX 78323 501 North Broadway, St. Louis, Missouri 63102-2121

THE ENVIRONMENT (AFCEE)
ACILITIES DYNAMIC PROTOTYPES DE
CURITY FORCE OPERATIONS I

Jacobs Project No.: FDWD0262

Room Finish Schedule

Drawing Title:

Date: 18 NOVEMBER 2011

Designed By: JN/MRB/OF
Drawn By: JN/MRB/OF
Checked By: JS

A-302

INTERIOR FINISH COLOR AND MATERIAL SCHEDULE					
ITEM	MATERIAL	NOTES			
04 14/411 C					
01 WALLS					
CMT	AOU VIOUS OF DAMAGITHE				

01 WALLS		
CWT-1	12" X 6" CERAMIC TILE	
CWT-2	12" X 6" CERAMIC TILE - ACCENT	
EWP-1	PAINT - EPOXY TYPICAL	
EWP-2	PAINT - EPOXY ACCENT	
EWP-3	PAINT - EPOXY ACCENT	
EWP-4	PAINT - EPOXY ACCENT	
PT-1	PAINT - TYPICAL	
PT-2	PAINT - ACCENT	
PT-3	PAINT - ACCENT	
PT-4	PAINT - ACCENT	

02 FLOORS		
CFT-1	12" X 12" CERAMIC FLOOR TILE	
CPT-1	2' X 2' CARPET TILE	
EFP-1	PAINT - EPOXY	
SC-1	SEALED CONCRETE	
VCT-1	12" X 12" VINYL COMPOSITION TILE	

03 BASE

500 SF 564 SF

CB-1 6" CERAMIC COVE BASE

RB-1	5" RUBBER BASE	
04 CEILING		
ACT-1	2' X 2' ACOUSTICAL CEILING TILE	
GYP.	PAINTED GYPSUM BOARD CEILING	
OPEN	EXPOSED TO STRUCTURE	
SEC. GYP.	PAINTED GYPSUM BOARD SECURITY CEILING	

05 MILLWORK	
LAM-1 PLASTIC LAMINATE - HORIZONTAL SURFACES	
LAM-2 PLASTIC LAMINATE - VERTICAL TEX SURFACES	TURE FINISH
SS-1 SOLID SURFACE	

						SH SCHEDULE	2				1
					FI	NISHES					
Room					W	ALLS				BIM Manual	
Numb		Floor	Base	Plan North	Plan East	Plan South	Plan West			Required	
er	Room Name	Finish	Finish	Wall	Wall	Wall	Wall	Ceiling Finish	Comments	Area	Actual Are
Modulo 6: Confi											

6.01	Waiting	EFP-1	-	EWP-1	EWP-1	EWP-1	EWP-1	SECURED GYP.	125 SF	131 SF
6.02	SP	EFP-1	-	EWP-1	EWP-1	EWP-1	EWP-1	SECURED GYP.	100 SF	68 SF
6.03	Admin. Processing	CPT-1	RB-1	PT-4	PT-1	PT-4	PT-1	SECURED GYP.	180 SF	182 SF
6.04	Storage	VCT-1	RB-1	PT-1	PT-1	PT-1	PT-1	SECURED GYP.	100 SF	127 SF
6.05	Janitor's Closet	VCT-1	RB-1	PT-1	PT-1	PT-1	PT-1	SECURED GYP.	60 SF	73 SF
6.06	Restroom	CFT-1	CB-1	CWT-1	CWT-1	CWT-1	CWT-1	SECURED GYP.	60 SF	64 SF
6.07	Female Shower	CT-3	CB-1	CWT-1	CWT-1	CWT-1	CWT-1	CONCRETE	60 SF	68 SF
80.6	Female Cell	EFP-1	-	EWP-1	EWP-1	EWP-1	EWP-1	CONCRETE	80 SF	80 SF
6.09	Female Segregated Cell	EFP-1	-	EWP-1	EWP-1	EWP-1	EWP-1	CONCRETE	80 SF	80 SF
6.10	Male Segregated Cell	EFP-1	-	EWP-1	EWP-1	EWP-1	EWP-1	CONCRETE	80 SF	80 SF
6.11	Male Cell	EFP-1	-	EWP-1	EWP-1	EWP-1	EWP-1	CONCRETE	80 SF	80 SF
5.12	Male Shower	CT-3	CB-1	CWT-1	CWT-1	CWT-1	CWT-1	CONCRETE	60 SF	68 SF
5.13	Visitation/Training Room	EFP-1	-	EWP-1	EWP-1	EWP-1	EWP-1	CONCRETE	120 SF	125 SF
6.14	Corridor	EFP-1	-	EWP-1	EWP-1	EWP-1	EWP-1	CONCRETE	120 SF	166 SF
5.15	Guard Room	VCT-1	RB-1	PT-1	PT-1	PT-4	PT-1	CONCRETE	120 SF	112 SF
5.16	Day/Recreation Room	EFP-1	-	EWP-1	EWP-1	EWP-3	EWP-1	CONCRETE	150 SF	144 SF
6.17	Outdoor Yard	-	-	-	-	-	-	-	250 SF	258 SF
6.18	Corridor	EFP-1	-	EWP-1	EWP-1	EWP-1	EWP-1	CONCRETE		75 SF
6.19	Corridor	EFP-1	-	EWP-1	EWP-1	EWP-1	EWP-1	CONCRETE		75 SF
6.20	Corridor	EFP-1	-	EWP-1	EWP-1	EWP-1	EWP-1	CONCRETE		39 SF
6.21	Corridor	EFP-1	-	EWP-1	EWP-1	EWP-1	EWP-1	CONCRETE		39 SF

7.01 Evidence Storage Vault	VCT-1	RB-1	PT-1	PT-1	PT-1	PT-1	ACT-1	175 SF	175 SF
7.02 Intel (S2) Office	CPT-1	RB-1	PT-4	PT-1	PT-1	PT-1	ACT-1	120 SF	120 SF
7.03 Files/ Equipment/ Supply Storage	VCT-1	RB-1	PT-1	PT-1	PT-1	PT-1	ACT-1	100 SF	107 SF
7.04 Corridor	CPT-1	RB-1	PT-1	PT-1	-	PT-1	ACT-1		61 SF
7.05 NCOIC Investigations	CPT-1	RB-1	PT-1	PT-4	PT-1	PT-1	ACT-1	120 SF	120 SF
7.06 Open Office/ Conference Area	CPT-1	RB-1	PT-3	PT-2	PT-3	PT-2	ACT-1	375 SF	372 SF
7.07 Interview 1	VCT-1	RB-1	PT-1	PT-1	PT-1	PT-1	ACT-1	100 SF	110 SF
7.08 Waiting Area	VCT-1	RB-1	PT-4	PT-1	PT-1	PT-1	ACT-1	80 SF	83 SF
7.09 Interview 2	VCT-1	RB-1	PT-1	PT-1	PT-1	PT-1	ACT-1	100 SF	95 SF

8.01	Files/ Office Equipment/ Supply Storage	VCT-1	RB-1	PT-1	PT-1	PT-1	PT-1	ACT-1	60 SF	58 SF
8.02	Open Office Area	CPT-1	RB-1	PT-1	PT-1 / PT-2	PT-4	PT-1	ACT-1	650 SF	642 SF
8.03	First Sergeant	CPT-1	RB-1	PT-1	PT-4	PT-1	PT-1	ACT-1	150 SF	153 SF
8.04	Waiting Area/ Secretary	CPT-1	RB-1	PT-1/ PT-2	PT-3	-	PT-3	ACT-1	220 SF	220 SF
8.05	Corridor	CPT-1	RB-1	-	PT-1/ PT-2/ PT-3	PT-1/ PT-2/ PT-3	PT-3	ACT-1	0 SF	142 SF
8.06	Files/ Office Equipment/ Supply Storage	VCT-1	RB-1	PT-1	PT-1	PT-1	PT-1	ACT-1	160 SF	160 SF
8.07	SFM	CPT-1	RB-1	PT-1	PT-4	PT-1	PT-1	ACT-1	180 SF	182 SF
8.08	Commander	CPT-1	RB-1	PT-1	PT-4	PT-1	PT-1	ACT-1	300 SF	289 SF
8.09	Command Conference Room	CPT-1	RB-1	PT-1	PT-3	PT-1	PT-2	GYP.	400 SF	410 SF

9A.1	Male Restroom	CT-3	CB-1	CWT-1 / CWT-2	CWT-1 / CWT-2	CWT-1 / CWT-2	CWT-1 / CWT-2	GYP.	400 SF	404 SF
9A.2	Female Restroom	CT-3	CB-1	CWT-1 / CWT-2	CWT-1 / CWT-2	CWT-1 / CWT-2	CWT-1 / CWT-2	GYP.	400 SF	404 SF
- A	lonitor	VCT-1	RB-1	PT-1	PT-1	PT-1	PT-1	GYP.	60 SF	69 SF
9A.3 1odule	Janitor e 9B: General Support	VCI-I	KD-1	PI-I	F 1-1	F 1-1	1121	GIF.	00 31	<u> </u>
		VC1-1	KD-1	F1-1	F 1-1	F 1-1	1 121	GIF.	00 31	09 31
lodule 9B.1	e 9B: General Support Mechanical Room	SC-1	RB-1	PT-1	PT-1	PT-1	PT-1	ACT-1	860 SF	860 SF
lodule 9B.1	e 9B: General Support									

VCT-1 RB-1 PT-1

9C.1 Break Room

9D.1	Restroom	CT-3	CB-1	CWT-1 / CWT-2	CWT-1 / CWT-2	CWT-1 / CWT-2	CWT-1 / CWT-2	GYP.	60 SF	56 SF
/lodul	e 10: Operations & Training/ S3									

PT-1

PT-2

GYP.

Module 10: Operations & Training/ S3									
10.01 S3 Officer	CPT-1	RB-1	PT-4	PT-1	PT-1	PT-1	ACT-1	120 SF	125 SF
10.02 S3 SMGT	CPT-1	RB-1	PT-4	PT-1	PT-1	PT-1	ACT-1	120 SF	127 SF
10.03 Work Stations	CPT-1	RB-1	PT-3	-	PT-3	PT-2	ACT-1	100 SF	100 SF
10.04 Planning Area	CPT-1	RB-1	PT-3	PT-2	PT-3	-	ACT-1/ GYP.	225 SF	233 SF
10.05 Assistant S3 MSGT	CPT-1	RB-1	PT-1	PT-1	PT-4	PT-1	ACT-1	120 SF	124 SF
10.06 PMD	CPT-1	RB-1	PT-1	PT-1	PT-4	PT-1	ACT-1	120 SF	127 SF

SCALE(S)) AS NOTED ON	THIS SHEET	ARE BASED (ON A FULL	36"X24" SIZE S

Comments

Door						DOOR	SCHEDU	JLE					
D00.			Door				Fire				Frame		
Number	Width	Height	Thickness	Material	Finish	Glazing	Rating	Hardware	Туре	Material	Finish	Jamb	Head
6.15A	3' - 4"	7' - 0"	0' - 2"										
6.15B	6' - 0"	7' - 0"	0' - 2"										
6.15C	3' - 4"	7' - 0"	0' - 2"										
6.15E	3' - 0"	7' - 0"	0' - 3"										
6.15F	3' - 0"	7' - 0"	0' - 3"										
6.15G	3' - 0"	7' - 0"	0' - 3"										
6.15H	3' - 0"	7' - 0"	0' - 3"										
6.16A	3' - 0"	7' - 0"	0' - 3"										
6.16B	3' - 0"	7' - 0"	0' - 3"										
7.01A	3' - 0"	7' - 0"	0' - 2"										
7.02A	3' - 0"	7' - 0"	0' - 2"										
7.03A	3' - 0"	7' - 0"	0' - 2"										
7.04A	3' - 0"	7' - 0"	0' - 2"										
7.05A	3' - 0"	7' - 0"	0' - 2"										
7.05B	3' - 0"	7' - 0"	0' - 2"										
7.06A	3' - 0"	7' - 0"	0' - 2"										
7.07A	3' - 0"	7' - 0"	0' - 2"										
7.07B	3' - 0"	7' - 0"	0' - 2"										
7.07C	3' - 0"	7' - 0"	0' - 2"										
7.09C	3' - 0"	7' - 0"	0' - 2"										
8.01A	3' - 0"	7' - 0"	0' - 2"										
8.02A	3' - 0"	7' - 0"	0' - 2"										
8.02B	3' - 0"	7' - 0"	0' - 2"										
8.03A	3' - 0"	7' - 0"	0' - 2"										
8.04A	3' - 0"	7' - 0"	0' - 2"										
8.06A	3' - 0"	7' - 0"	0' - 2"										
8.07A	3' - 0"	7' - 0"	0' - 2"										
8.08A	3' - 0"	7' - 0"	0' - 2"										
8.09A	3' - 0"	7' - 0"	0' - 2"										
8.09B	3' - 0"	7' - 0"	0' - 2"										
9A.1A	3' - 0"	7' - 0"	0' - 2"										
9A.2A	3' - 0"	7' - 0"	0' - 2"										
9A.3A	3' - 0"	7' - 0"	0' - 2"										
9B.1A	6' - 0"	7' - 0"	0' - 2"										
9B.2A	6' - 0"	7' - 0"	0' - 2"										
9B.3A	3' - 0"	7' - 0"	0' - 2"										
9C.1A	6' - 0"	7' - 0"	0' - 2"										
9C.1B	3' - 0"	7' - 0"	0' - 2"										
9D.1A	3' - 0"	7' - 0"	0' - 2"										
9D.1C	3' - 0"	7' - 0"	0' - 2"										
10.01A	3' - 0"	7' - 0"	0' - 2"										
10.02A	3' - 0"	7' - 0"	0' - 2" 0' - 2"										
	3' - 0" 3' - 0"	7' - 0" 7' - 0"	0' - 2"										
10.04A 10.05A	3 - 0	7 - 0	0' - 2"										

					DOOR	SCHED	ULE					_
Door Number	Width	Height	Door Thickness Materia	al Finish	Glazing	Fire Rating	Hardware	Туре	Frame Material Finish	Jamb	Head	Comments
1.01A	3' - 0"	7' - 0"	0' - 2"									
1.02A	3' - 0"	7' - 0"	0' - 2"									
1.03A	3' - 0"	7' - 0"	0' - 2"									
1.04A	3' - 0"	7' - 0"	0' - 2"									
1.05A	3' - 0"	7' - 0"	0' - 2"									
1.06A	3' - 0"	7' - 0"	0' - 2"									CASED OPENING
1.08A	3' - 0"	7' - 0"	0 2									0/1020 01 2111110
1.09A	3' - 0"	7' - 0"	0' - 2"									
1.09A	3' - 0"	7' - 0"	0' - 2"									SECURE DOOR
												SECURE DOOR
2.01A	6' - 0"	7' - 0"	0' - 2"									CACED ODENING
2.01B	5' - 0"	7' - 0"										CASED OPENING
2.02A	3' - 0"	7' - 0"	0' - 2"									
2.03A	3' - 0"	7' - 0"	0' - 2"									
2.05A	3' - 0"	7' - 0"	0' - 2"									
2.06A	5' - 8"	6' - 8"	0' - 2"									
2.06C	5' - 0"	7' - 0"										CASED OPENING
2.09A	3' - 0"	7' - 0"	0' - 2"									
2.10A	3' - 0"	7' - 0"	0' - 2"									
2.11A	3' - 0"	7' - 0"	0' - 2"									
2.12A	3' - 0"	7' - 0"	0' - 2"									
3.01A	3' - 0"	7 - 0"	0' - 2"									
3.01B	3' - 0"	7' - 0"	0' - 2"									
3.01C	3' - 0"	7' - 0"	0' - 2"									
3.02A	3' - 0"	7' - 0"	0' - 2"									
3.02B	3' - 0"	7' - 0"	0' - 2"									
3.03A	3' - 0"	7' - 0"	0' - 2"									
3.04C	10' - 0"	10' - 0"	0' - 2"									
3.04D	3' - 0"	7' - 0"	0' - 2"									
3.05A	3' - 0"	7' - 0"	0' - 2"									
3.06A	3' - 0"	7' - 0"	0' - 2"									
3.06B	3' - 0"	7' - 0"	0' - 2"									
4.01A	3' - 0"	7' - 0"	0' - 2"									
4.02A	3' - 0"	7' - 0"	0' - 2"									
4.03A	3' - 0"	7' - 0"	0' - 2"									
4.04A	3' - 0"	7' - 0"	0' - 2"									
4.05A	3' - 0"	7' - 0"	0' - 2"									
4.06A	3' - 0"	7' - 0"	0' - 2"									
4.06B	3' - 0"	7' - 0"	0' - 2"									
4.07A	3' - 0"	7' - 0"	0' - 2"									
4.07B	3' - 0"	7' - 0"	0' - 2"									
4.08A	3' - 0"	7' - 0"	0' - 2"									
4.09B	3' - 0"	7' - 0"	0' - 2"									
4.10A	3' - 0"	7' - 0"	0' - 2"									
4.11A	3' - 0"	7' - 0"	0' - 2"									
4.12A	3' - 0"	7' - 0"	0' - 2"									
		7' - 0"	0' - 2"									
4.13A	3' - 0"											OFOURE DOOR
4.14A	3' - 0"	7' - 0"	0' - 2"									SECURE DOOR
4.15A	3' - 0"	7' - 0"	0' - 2"									SECURE DOOR
4.16A	3' - 0"	7' - 0"	0' - 2"									SECURE DOOR
4.17A	3' - 4"	7' - 0"	0' - 2"									
4.18A	3' - 0"	7' - 0"	0' - 2"									SECURE DOOR
5.01A	3' - 0"	7' - 0"	0' - 2"									
5.02A	3' - 0"	7' - 0"	0' - 2"									
5.03A	3' - 0"	7' - 0"	0' - 2"									
5.04A	3' - 0"	7' - 0"	0' - 2"									
5.05A	3' - 0"	7' - 0"	0' - 2"									
5.06A	3' - 0"	7'-0"	0' - 2"									
		7 - 0"										
5.07A	3' - 0"		0' - 2"									
5.08A	3' - 0"	7' - 0"	0' - 2"									
5.10A	2' - 8"	7' - 0"	0' - 2"									
5.11A	3' - 0"	7' - 0"	0' - 2"									
5.11B	3' - 0"	7' - 0"	0' - 2"									
5.13A	3' - 0"	7' - 0"	0' - 2"									
5.14A	2' - 8"	7' - 0"	0' - 2"									
5.15B	3' - 0"	7' - 0"	0' - 2"									
6.01A	3' - 4"	7' - 0"	0' - 2"									
6.01B	3' - 4"	7' - 0"	0' - 2"									
6.02A	3' - 4"	7' - 0"	0' - 2"									
6.02B	3' - 4"	7' - 0"	0' - 2"									
6.03A	3' - 4"	7' - 0"	0' - 2"									
6.03B	3' - 4"	7' - 0"	0' - 2"									
6.04A	3' - 4"	7' - 0"	0' - 2"									
6.05A	3' - 4"	7' - 0"	0' - 2"									
6.06A	3' - 4"	7' - 0"	0' - 2"									
6.07A	3' - 4"	7' - 0"	0' - 2"									HALF DOOR
6.08A	3' - 0"	7' - 0"	0' - 3"									SLIDING
												DETENTION DOC
6.09A	3' - 0"	7' - 0"	0' - 3"									SLIDING
	. .											DETENTION DOC
6.10A	3' - 0"	7' - 0"	0' - 3"									SLIDING

6.10A 3' - 0"

6.12A 3' - 4"

6.13A 3' - 0"

6.14C 3' - 4"

6.14D 3' - 4"

7' - 0" 0' - 3"

7' - 0" 0' - 2" 7' - 0" 0' - 2"

0' - 2"

0' - 3"

7' - 0"

7' - 0"

7' - 0"

DOOR SCHEDULE

JACOBS

NOT FOR CONSTRUCTION

911 Central Parkway N., Suite 425 San Antonio, TX 78323 501 North Broadway, St. Louis, Missouri 63102-2121

Jacobs Project No.:

Drawing Title:

Door Schedule

FDWD0262

Date: 18 NOVEMBER 2011

Designed By: JN/MRB/OF Drawing No.:

Drawn By: JN/MRB/OF
Checked By: JS

A-303

SLIDING DETENTION DOOR

SLIDING DETENTION DOOR

SLIDING DETENTION DOOR

HALF DOOR

$C \times C \times$	AS NOTED ON	THIS SHEET			つた!! Vつ イ!!	017E 0U
CALEIO	I AO NO LED ON		AKE DASEU '	UN A FULL	30 AZ4 3	SIZE SH

						WINDC	W SCF	IEDULE			
		R.O.						Glazir	ng		
Mark	Width	Height	Туре	Manufacturer	Model	Material	Finish	Head Jamb Sill Thickness	Туре	Head Height	Comments
.06A	3' - 0"		Pass Drawer and Counter							' - 0"	
.08A	3' - 0"		Pass Drawer and Counter						7	' - 0"	
.08B	3' - 0"		Pass Drawer and Counter						7	' - 0"	
.08C	3' - 0"		Pass Drawer and Counter							' - 0"	
.03A	3' - 0"		Fixed							' - 0"	
.03B	3' - 0"		Fixed							' - 0"	
.04A	3' - 0"		Pass Drawer and Counter						7	' - 0"	
.03A	3' - 0"		Fixed						7	' - 0"	
.03B	3' - 0"		Fixed						7	' - 0"	
.04A	3' - 0"		Fixed							' - 0"	
.04B	3' - 0"	4' - 0"	Fixed						7	' - 0"	
.03A	3' - 0"	4' - 0"	Pass Drawer and Counter						7	' - 0"	
.03B	5' - 0"	3' - 6"	Roll-Up Shutter with Counter						7	' - 0"	
.03C	3' - 0"	4' - 0"	Fixed						7	' - 0"	
.03D	3' - 0"	4' - 0"	Fixed						7	' - 0"	
.08A	1' - 6"	4' - 0"	Fixed						7	' - 0"	
.09A	1' - 6"	4' - 0"	Fixed						7	' - 0"	
.10A	1' - 6"	4' - 0"	Fixed						7	' - 0"	
.11A	1' - 6"	4' - 0"	Fixed						7	' - 0"	
.13A	1' - 6"	4' - 0"	Fixed						7	' - 0"	
.13B	1' - 6"	4' - 0"	Fixed						7	' - 0"	
.13C	1' - 6"	4' - 0"	Fixed						7	' - 0"	
.15A	3' - 0"	4' - 0"	Fixed						7	' - 0"	
.15B	2' - 6"	4' - 0"	Fixed						7	' - 0"	
.15C	3' - 0"	4' - 0"	Pass Drawer and Counter						7	' - 0"	
.15D	2' - 6"	4' - 0"	Fixed						7	' - 0"	
.15E	3' - 0"	4' - 0"	Fixed						7	' - 0"	
.16A	3' - 0"	1' - 6"	Transom with Trim						7	' - 6"	
.16B	3' - 0"	1' - 6"	Transom with Trim						7	' - 0"	
.16C	3' - 0"	1' - 6"	Transom with Trim						7	' - 0"	
.06A	3' - 0"	4' - 0"	Pass Drawer and Counter						7	' - 0"	

SHEET JACOBS

NOT FOR CONSTRUCTION

911 Central Parkway N., Suite 425 San Antonio, TX 78323 501 North Broadway, St. Louis, Missouri 63102-2121

AIR FORCE CENTER FOR THE ENVIRONME FACILITIES DYNAMIC PROT

Jacobs Project No.:

FDWD0262

Window Schedule

Date: 18 NOVEMBER 2011

Designed By: JN/MRB/OF Drawing No.:

Drawn By: JN/MRB/OF Checked By: JS

A-304

3' - 0" | 4' - 0"

Pass Drawer and Counter

Drawing Title: